

## MISSOULA RURAL FIRE DISTRICT REQUEST FOR PROPOSALS STATION 6 ROOF REPLACEMENT

Notice is hereby given that the Missoula Rural Fire District ("Fire District") is seeking proposals from qualified contractors to remove the existing roofing and furnish materials to complete the installation of a new pitched roof on Station 6 located at 8455 Mullan Road, Missoula, Montana.

Copies of the RFP and all questions relating to the scope of services should be directed to: MMW Architects, Kent Means: 125 West Alder Street, Missoula, Montana 59802; (406) 543-5800; kent@mmwarchitects.com. Questions relating to proposal procedures should be directed to Chris Newman, Fire Chief (406)549-6172, cnewman@mrfdfire.org.

Proposals are due no later than 5:00 p.m. on June 12, 2023 and must be provided as a single, searchable PDF document file and be submitted digitally as an email attachment to cnewman@mrfdfire.org. The subject line of the transmittal email shall clearly identify the RFP title, company name and due date/time. The Respondent is solely responsible for assuring delivery by the deadline. Late proposals will NOT be accepted.

Public opening of the proposals will occur at the Fire District Board of Trustees meeting on June 13, 2023 at 4:00 p.m. located at 2521 South Ave West, Missoula, Montana.

A mandatory site visit is scheduled for May 25, 2023 at 10:00 a.m.

Dated this 9th day of May, 2023

\_\_\_\_\_

Ben Murphy Chair, Board of Trustees Missoula Rural Fire District

Publish:

Missoulian: May 12, 2023 & May 19, 2023



## MISSOULA RURAL FIRE DISTRICT REQUEST FOR PROPOSALS STATION 6 ROOF REPLACEMENT

Notice is hereby given that the Missoula Rural Fire District ("Fire District") is seeking proposals from qualified contractors to remove the existing roofing and furnish materials to complete the installation of a new pitched roof on Station 6 located at 8455 Mullan Road, Missoula, Montana.

## I. INTRODUCTION

This Request for Proposal ("RFP") is issued under the authority of the Missoula Rural Fire District Procurement Policy. The RFP process is a procurement option which allows the award to be based on evaluation criteria in addition to cost. Only the evaluation criteria outlined in this RFP will be used.

The Fire District encourages free and open competition to obtain quality, cost-effective services and products. The specifications contained in proposal requests are designed to accomplish this objective.

## II. INSTRUCTIONS TO RESPONDENTS/SUBMISSION PROCEDURES

Copies of the RFP and all questions relating to the scope of services should be directed to: MMW Architects, Kent Means: 125 West Alder Street, Missoula, Montana 59802; (406) 543-5800; kent@mmwarchitects.com. Questions relating to proposal procedures should be directed to: Chris Newman, Fire Chief: (406) 549-6172; cnewman@mrfdfire.org.

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Public opening of the proposals will occur at the Fire District Board of Trustees meeting on June 13, 2023 at 4:00 p.m. located at 2521 South Ave West, Missoula, Montana.

The deadline for questions related to this RFP is 5:00 p.m. on May 30, 2023. Any interpretation or correction of this RFP will be emailed to all recipients of this RFP by 5:00 p.m. on June 2, 2023.

A mandatory site visit is scheduled for May 25, 2023 at 10:00 a.m.

By offering to perform services under this RFP, all Respondents agree to be bound by the laws of the State of Montana, including, but not limited to, applicable wage rates, payments, gross receipts taxes, building codes, public works contracts, equal opportunity employment practices, safety and non-discrimination statutes.

## III. RFP TIMELINE

EVENT DATE

RFP Issue Date May 9, 2023

Publication Dates May 12, 2023 & May 19, 2023

Mandatory Site Visit

Deadline for Questions

Proposal Due Date

Evaluation of Proposals

May 25, 2023

May 30, 2023

June 12, 2023

June 13-15, 2023

Respondent Interviews (if necessary)

Contract Award

TBD

## IV. SCOPE OF SERVICES

The project consists of construction of a pitched roof using framing and trusses to cover an existing flat roof on Station 6 of approximately 1554 square feet. The project will require removal of some existing roof, framing, gutter and siding components that are comprised of asphalt shingles, flat roof membrane, rigid foam insulation, plywood, concrete lap siding and flashing. Additional framing to tie the new pitched roof to the existing pitched roof will be required to maintain the pitch and roof line(s). The new roof will be sheathed and roofing material applied and mechanical and plumbing extension associated with raising the roof line will be necessary. The project also includes siding, gutter and paint. Architectural plans and specifications developed by MMW Architects are attached as Exhibit A and incorporated herein.

## V. PROPOSAL REQUIREMENTS

Respondents interested in providing the services described above are requested to submit the following information. Responses to each item should appear in the same order as in this RFP and should identify the item to which the responses apply.

- a) Company Profile & Experience of Personnel
  - Introductory letter or statement of interest;
  - Firm name, address, and principal contact for this RFP;
  - A general description of the firm including its primary source of business, organizational structure and size, number of employees, and years of experience performing services or supplying products similar to those described within this RFP;
  - A summary of qualifications, work experience, education, certification, and skills for all key personnel; and
  - Provide a list of subcontractors that will be performing the work.
- b) Company Experience/References
  - A list of three similar past projects or products provided;
  - The dates the services/products were provided;
  - The client for whom the services were provided; and
  - Contact information for the client.
- c) Project Timeline
  - Provide a timeline for project completion.

- d) Cost Proposal/Warranties
  - Detailed cost breakdown to complete project;
  - Detailed extended material and labor warranties applicable to project; and
  - Identify and describe any other important cost-based information such as additional charges for unanticipated events and how they would be determined.

All proposals must be signed by an individual legally authorized to bind the Respondent. All proposals submitted shall be legally binding upon the Respondent for 120 calendar days from the proposal submission deadline. Negligence on the part of the Respondent in preparing the proposal confers no right of withdrawal after the time fixed for submission of proposals.

## VI. CLASSIFICATION AND EVALUATION OF PROPOSALS

## Classification

All proposals will be classified as either "responsive" or "non-responsive." A proposal is considered "responsive" if it conforms in all material respects to the requirements of the RFP.

## **Responsibility**

The evaluation committee will make a determination whether a Respondent has met the standards of responsibility based on the requirements of the RFP. Factors used to determine the responsibility may include whether the Respondent has:

- The appropriate financial, material, equipment, or human resources to meet all contractual requirements;
- The legal ability to contract with the Fire District;
- A satisfactory record of past performance.

A Respondent may be deemed "nonresponsible" at any time during the procurement process if information surfaces to support such a determination.

## **Evaluation of Proposals**

The evaluation committee will review and evaluate the proposals according to the below criteria based on a total number of 100 points:

25 points
25 points
25 points
25 points

The evaluation committee may ask Respondents to appear for interviews or to provide written responses to items requiring clarification. Any costs associated with interviews or product demonstrations are the sole responsibility of the Respondent.

The Fire District may make such investigations as are deemed necessary to determine the ability of the Respondent to provide the services specified. The Fire District reserves the right

to reject any proposal if the evidence obtained fails to satisfy the Fire District that the Respondent is properly qualified to perform the obligations of the contract. This includes the Fire District's ability to reject a proposal based on negative references.

After the evaluation of the proposals and interviews, if conducted, the evaluation committee will recommend a contract award, which will be communicated to the selected Respondent. If the Respondent does not accept all material terms of Fire District's contract, the Fire District may move to next ranked Respondent or cancel the RFP. The work described in the RFP may begin only after the contract is signed by all parties.

## VII. PUBLIC INFORMATION

All information received in response to this RFP, including copyrighted material, is deemed public information and with one exception will be available for public viewing and copying after the proposal deadline. The public will not be able to view bona fide trade secrets meeting the requirements of the Uniform Trade Secrets Act, Title 30, Chapter 14, Part 4, MCA. Confidential information meeting the requirements of the Uniform Trade Secrets Act will be available for review only by the Fire Chief, the evaluation committee members, and limited other designees.

Before the RFP is made available to the public, the Fire Chief will remove the confidential information if the following conditions are met:

- Confidential information is clearly marked and separated from the rest of the proposal.
- No confidential material is contained in the cost section.
- An affidavit from the Respondent's legal counsel attesting to and explaining the
  validity of the trade secret claim is attached to the proposal. Counsel must use the
  State of Montana "Affidavit for Trade Secret Confidentiality" in requesting the trade
  secret claim. This affidavit form is available at the State Procurement Bureau's website
  (https://spd.mt.gov).


The Respondent shall pay all legal costs and fees associated with defending a claim for confidentiality if a "right to know" request is received from another party.

## VIII. RESERVATION OF RIGHTS

This RFP shall not commit the Fire District to enter into an agreement, to pay any expenses incurred in preparation of any response to this request, or to procure or contract for any supplies, goods or services.

The Fire District reserves the right to:

- Cancel or terminate this RFP;
- Reject any or all proposals received in response to this RFP;
- Waive any minor irregularities, informalities, or failure to conform to the RFP.

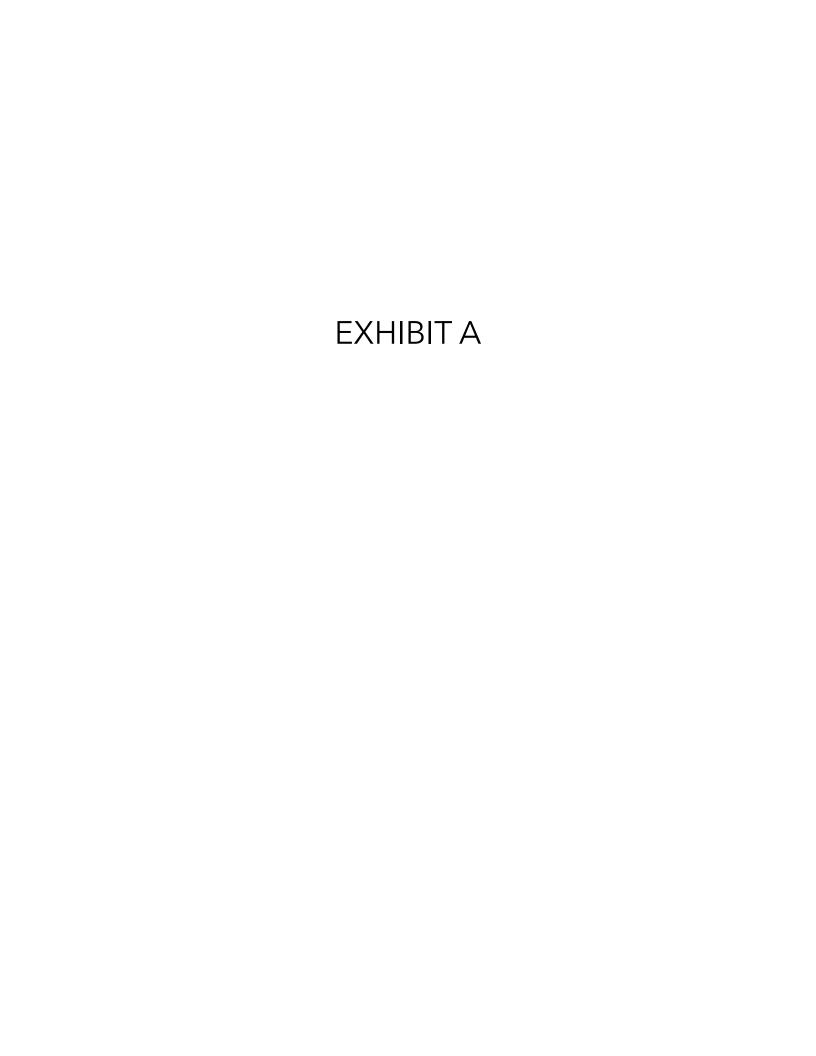

MISSOULA, MT

## PROJECT DIRECTORY

## PROJECT ADDRESS

## **OWNER** CONTACT: CHRIS NEWMAN

EMAIL: CNEWMAN@MRFDFIRE.ORG

MISSOULA RURAL FIRE DISTRICT 2521 SOUTH AVE WEST MISSOULA, MT 59804 PH: (406) 549-6172

## **ARCHITECT**

CONTACT: KENT MEANS EMAIL: KENT@MMWARCHITECTS.COM CONTACT: MARK STELLING EMAIL: MARK@MMWARCHITECTS.COM

MMW ARCHITECTS 125 W. ALDER ST MISSOULA, MT 59802 PH: (406) 543-5800

## MMW ARCHITI

ROOF MRFD

DESCR

PROJECT # 23.008 03.20.2023 DATE

**COVER SHEET** 

G-001

## PROJECT # 23.008

ABBREVIATIONS								
Notation No.	Text	Notation No.	Text					
AB	ANCHOR BOLT	N	NORTH					
ACT	ACOUSTICAL CEILING TILE	NIC	NOT IN CONTRACT					
ADJ	ADJUSTABLE	NLT	NAIL LAMINATED TIMBER					
AFF	ABOVE FINISH FLOOR	NO	NUMBER					
AL	ALUMINUM	NOM	NOMINAL					
ANOD ARCH	ANODIZED ARCHITECT	NTS	NOT TO SCALE					
		O/O	OUT TO OUT					
BLDG	BUILDING	OC	ON CENTER					
BM	BEAM	OCC	OCCUPANT					
ВО	BOTTOM OF	OD	OUTSIDE DIAMETER					
00	CODNED CHARD	OPG	OPENING					
CG CJT	CORNER GUARD CONTROL JOINT	OPP OSCI	OPPOSITE OWNER SUPPLIED CONTRACTOR					
CLG	CEILING	0301	INSTALLED					
CLG	CLEAR	OSOI	OWNER SUPPLIED OWNER					
CMU	CONCRETE MASONRY UNIT		INSTALLED					
CO	CASED OPENING	OTS	OPEN TO STRUCTURE					
COL	COLUMN							
CONC	CONCRETE	P-LAM	PLASTIC LAMINATE					
CONT	CONTINUOUS	PC	POLISHED CONCRETE					
CONTR	CONTRACT, CONTRACTOR	PH	PREHUNG					
CPT	CARPET	PIP	POURED IN PLACE					
CT	CERAMIC TILE	PL	PLATE					
		PNT	PAINT, PAINTED					
DIA	DIAMETER	PT	PRESSURE TREATED					
DIM	DIMENSION	PTD PVC	PAPER TOWEL DISPENSER					
DISP	DISPENSER	PVC	POLYVINYL CHLORIDE					
DIV	DIVISION	R	RISER					
DL	DEAD LOAD	RAD	RADIUS					
DWG	DRAWING	RB	RUBBER BASE					
E	EAST	RD	ROOF DRAIN					
EA	EACH	REINF	REINFORCE, REINFORCEMENT					
ELEC	ELECTRIC	REQ'D	REQUIRED					
ELEV	ELEVATION	REV	REVISION					
EQUIP	EQUIPMENT	RO	ROUGH OPENING					
EX	EXISTING	RS	ROLLER SHADE					
EXP	EXPANSION	RWL	RAIN WATER LEADER					
EXT	EXTERIOR							
		S	SOUTH					
FD	FLOOR DRAIN	SC	SOLID CORE					
FF	FACTORY FINISH	SCHED	SCHEDULE					
FIN	FINISH	SHT'G SIM	SHEATHING					
FLG	FLASHING	SLC	SIMILAR SEALED CONCRETE					
FND	FOUNDATION	SPEC(S)	SPECIFICATION					
FOC	FACE OF CONCRETE	SQ SQ	SQUARE					
FOM	FACE OF MASONRY	STD	STANDARD					
FOS	FACE OF STUDS FIBERGLASS REINFORCED	STG	STORAGE					
FRP	PLASTIC	STL	STEEL					
FT	FOOT	STRUCT	STRUCTURAL					
FTG	FOOTING	SUSP	SUSPENDED					
		SV	SHEET VINYL					
GA	GAUGE							
GALV	GALVANIZED	Т	TREAD					
GEN	GENERAL	T&G	TONGUE AND GROOVE					
GWB	GYPSUM WALL BOARD	TEL	TELEPHONE					
		TOB	TOP OF FOOTING					
HDWD	HARDWOOD	TOF	TOP OF MASONEY					
HM	HOLLOW METAL	TOM TOP	TOP OF MASONRY TOP OF PLATE					
HORIZ	HORIZONTAL	TOS	TOP OF PLATE TOP OF SLAB					
HT	HEIGHT	TOW	TOP OF WALL					
HVAC	HEATING-VENTILATING-AIR CONDITIONING	TV	TELEVISION					
HW	HOT WATER TANK	TYP	TYPICAL					
ID	INCIDE DIAMETED	LIDO	LINIEODM BLIII DINO CODE					
ID INCL	INSIDE DIAMETER INCLUDE, INCLUDING	UBC UNO	UNIFORM BUILDING CODE UNLESS NOTED OTHERWISE					
INCL	INCLUDE, INCLUDED, INCLUDING INSULATE, INSULATION,	UNU	OINLESS INCTED CTHEKWISE					
IINOUL	INSULATED	VCT	VINYL COMPOSITION TILE					
INT	INTERIOR	VERT	VERTICAL					
	<del></del>	VERT	VERTICAL VERTICAL GRAIN					
JAN	JANITOR	VG VR	VAPOR RETARDER					
JT	JOINT	VIX	W OKKEINKOLK					
		W	WEST					
KO	KNOCK OUT	W/	WITH					
		WC	WATER CLOSET					
LAM	LAMINATED	WD	WOOD					
I AV	LAVATORY	WOM	MALK OFF MAT					

WALK-OFF MAT

WEIGHT

WATERPROOF(ING)

WELDED WIRE FABRIC

WELDED WIRE MESH

LAVATORY

LIVE LOAD

MATERIAL

MAXIMUM **MECHANICAL** 

MINIMUM

METAL

LUXURY VINYL TILE

MANUFACTURER

MISCELLANEOUS

MASONRY OPENING

LAV

LVT

MAX

MFR

MIN

MO

MTL

## SHEET INDEX

NUMBER	SHEET NAME
GENERAL	
G-001	COVER SHEET
STRUCTURAL	
S-101	ROOF FRAMING PLAN
ARCHITECTUR	AL
A-100	EXISTING ROOF PLAN & DEMO PLAN
A-101	ROOF PLAN
A-201	ELEVATIONS
A-301	BUILDING SECTIONS
A-501	EXTERIOR DETAILS

## **OUTLINE SPECIFICATIONS**

## **DIVISION ONE: GENERAL REQUIREMENTS**

<u>0110 - BIDDING/REQUIREMENTS</u> - OWNER/CONTRACT CONTACT TO BE AIA A104.

## **DIVISION SIX: WOOD & PLASTICS** 06100 - ROUGH CARPENTRY

- #2 OR BETTER

- ROOF 5/8" OSB OR PLYWOOD, STRUCTUAL SHEATHING - WALLS - 1/2" OSB OR PLYWOOD, STRUCTURAL SHEATHING, EXP. 1 - ROUGH FRAMING:
- SHOP FABRICATED WOOD TRUSSES - PERFORMANCE REQUIREMENTS
- DELEGATED DESIGN: ENGAGE A QUALIFIED PROFESIONAL ENGINEER, TO DESIGN METAL-PLATE-CONNECTED WOOD TRUSSES. - STRUCTURAL PERFORMANCE: METAL-PLATE-CONNECTED WOOD TRUSSES SHALL BE CAPABLE OF WHITHSTANDING DESIGN LOADS WITHIN LIMITS AND UNDER CONDITIONS INDICATED. COMPLY WITH
  - REQUIREMENTS IN TPI 1 UNLESS MORE STRINGENT REQUIREMENTS ARE SPECIFIED BELOW. - DESIGN LOADS: PER CODE REQ.
- MAXIMUM DEFLECTION UNDER DESIGN LOADS - ROOF TRUSSES: VERTICAL DEFLECTION OF 1/360 OF SPAN - FLOOR TRUSSES: VERTICAL DEFLECTION OF 1/360 OF SPAN - COMPLY WITH APPLICABLE REQUIREMENTS AND RECOMMENDATIONS OF TPI 1, TPI DSB, AND SBCA BCSI.
- WOOD STRUCTURAL DESIGN STANDARD: COMPLY WITH APPLICABLE REQUIREMENTS IN AF&PA'S "NATIONAL DESIGN SPECIFICATIONS FOR WOOD CONSTRUCTION" AND ITS "SUPPLEMENT"

- **ASPHALT SHINGELS:** GAF TIMBERLINE HDZ, EQUAL, COLOR TO MATCH EXISTING.
- GUTTERS AND DOWNSPOUTS - GUTTERS - 5" K STYLE, ALUMINUM, COLOR TO MATCH EXISTING - DOWNSPOUTS - 3" X 4" ALUMINUM, COLOR TO MATCH EXISTING FLASHING - ALUMINUM TO MATCH GUTTER COLOR
- ICE & WATER SHIELD - GRACE, ICE & WATER SHIELD, .04"
- LAP SIDING HARDI PLANK FIBER CEMENT, CEDARMILL LAP SIDING
- FURNISH AND INSTALL AIR INFILTRATION BARRIER OVER EXTERIOR OF WALL SHEATHING AT ALL LOCATIONS. - TAPE AND SEAL ALL SEAMS AND PENETRATIONS PER MANUFACTURER RECOMMENDATIONS
- DUPONT TYVEK HOMEWRAP OR EQUAL - SEALING TAPE/FASTENERS: DUPONT TYVEK TAPE
- DUPONT TYVEK WRAPCAPS, NAILS WITH PLASTIC WASHERS OR 1" CROWN

## 15000 - GENERAL MECHANICAL REQUIREMENTS

- MECHANICAL, SEE DRAWINGS
- EXTEND MECHANICAL AND PLUMBING VENTS AS REQUIRED AND TO MEET ALL APPLICABLE CODES AND STANDARDS

**VICINITY MAP** 

**GENERAL NOTES** 

1. CONTRACTOR SHALL VERIFY ALL DIMENSIONS AND JOB SITE CONDITIONS BEFORE COMMENCING WORK AND SHALL REPORT ANY DISCREPANCIES TO THE ARCHITECT. 2. USE WRITTEN DIMENSIONS. DO NOT SCALE DRAWINGS. WHERE NO DIMENSION IS PROVIDED, CONSULT THE ARCHITECT FOR CLARIFICATION BEFORE PROCEEDING

TEMPORARY SUPPORTS, ETC. IS THE SOLE RESPONSIBILITY OF THE CONTRACTOR

RESPONSIBLE FOR THE STABILITY OF THE STRUCTURE PRIOR TO THE COMPLETION

AND HAS NOT BEEN CONSIDERED BY THE ARCHITECT. THE CONTRACTOR IS

4. GENERAL CONTRACTOR TO COORDINATE ARCHITECTURAL DRAWINGS WITH

5. BLOCKING TO BE 2x SOLID WOOD BLOCKING OR AS INDICATED ON DRAWINGS.

6. MATERIALS AND FINISHES ARE TO BE AS SPECIFIED. SUBSTITUTIONS SHALL BE

7. VERIFY EXACT LOCATIONS AND ROUTING OF NEW AND EXISTING UTILITIES PRIOR TO

STARTING EXCAVATION. REPAIR ANY DAMAGE TO EXISTING PIPES, UTILITIES OR

3. THE DESIGN, ADEQUACY AND SAFETY OF ERECTING BRACING, SHORING,

OF WALLS, CEILING, AND FINISH MATERIALS.

MECHANICAL, ELECTRICAL, AND PLUMBING.

PROVIDE BLOCKING FOR ALL ACCESSORIES.

RELATED FACILITIES AT CONTRACTOR'S EXPENSE.

MADE BY APPROVAL PRIOR TO BID.



## PROJECT STATISTICS

APPLICABLE CODES:	2018 IBC, 2012 IECC, 20
	(REFER TO OTHER TRA
	FOR ADDITIONAL CODE
	REQUIREMENTS)
SEISMIC ZONE:	SEE STRUCTURAL NOT
BUILDING TYPE:	TYPE V-B
BUILDING OCCUPANCY:	S-S, B, R-2
FIRE SPRINKLER:	NONE

## LEGAL DESCRIPTION:

4 (A5.1)2

AREA IS LOCATED IN THE EL MAR ESTATES - PHASE 1, S15, T13 N, R20 W, BLOCK 008, LOT 003, 1ST SUPP MISSOULA COUNTY, MONTANA.


## **LEGEND**

NAME

**ROOM NAME** 

SHEET NUMBER

DAT. POINT

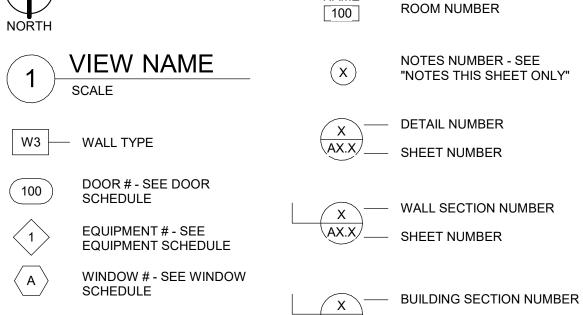

— INTERIOR ELEVATION NUMBER

SHEET NUMBER

**KEYED NOTES** 

REMOVE 4'-0" OF ROOFING AND SHEATHING FULL LENGTH OF EXISTING ROOF

REMOVE ALL EXISTING ROOF MEMBRANE

REMOVE 2'-0" SECTION OF SHEATHING CONTIUOUS TO ALLOW VENTILATION

CONTINUE MECHANICAL EQUIPMENT THROUGH NEW

REMOVE (E) EAVE

REMOVE EXISTING PARAPET CAP

ROOF MRFD MULL MISSOULA

DESCR DATE


PROJECT # 23.008

03.20.2023

**EXISTING ROOF PLAN** & DEMO PLAN

**A-100** 

EXISTING ROOF PLAN
1/4" = 1'-0"

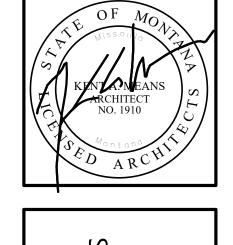




REVISION SCHEDULE DESCR DATE PROJECT # 23.008 DATE 03.20.2023 ROOF

FRAMING PLAN

**S-101** 

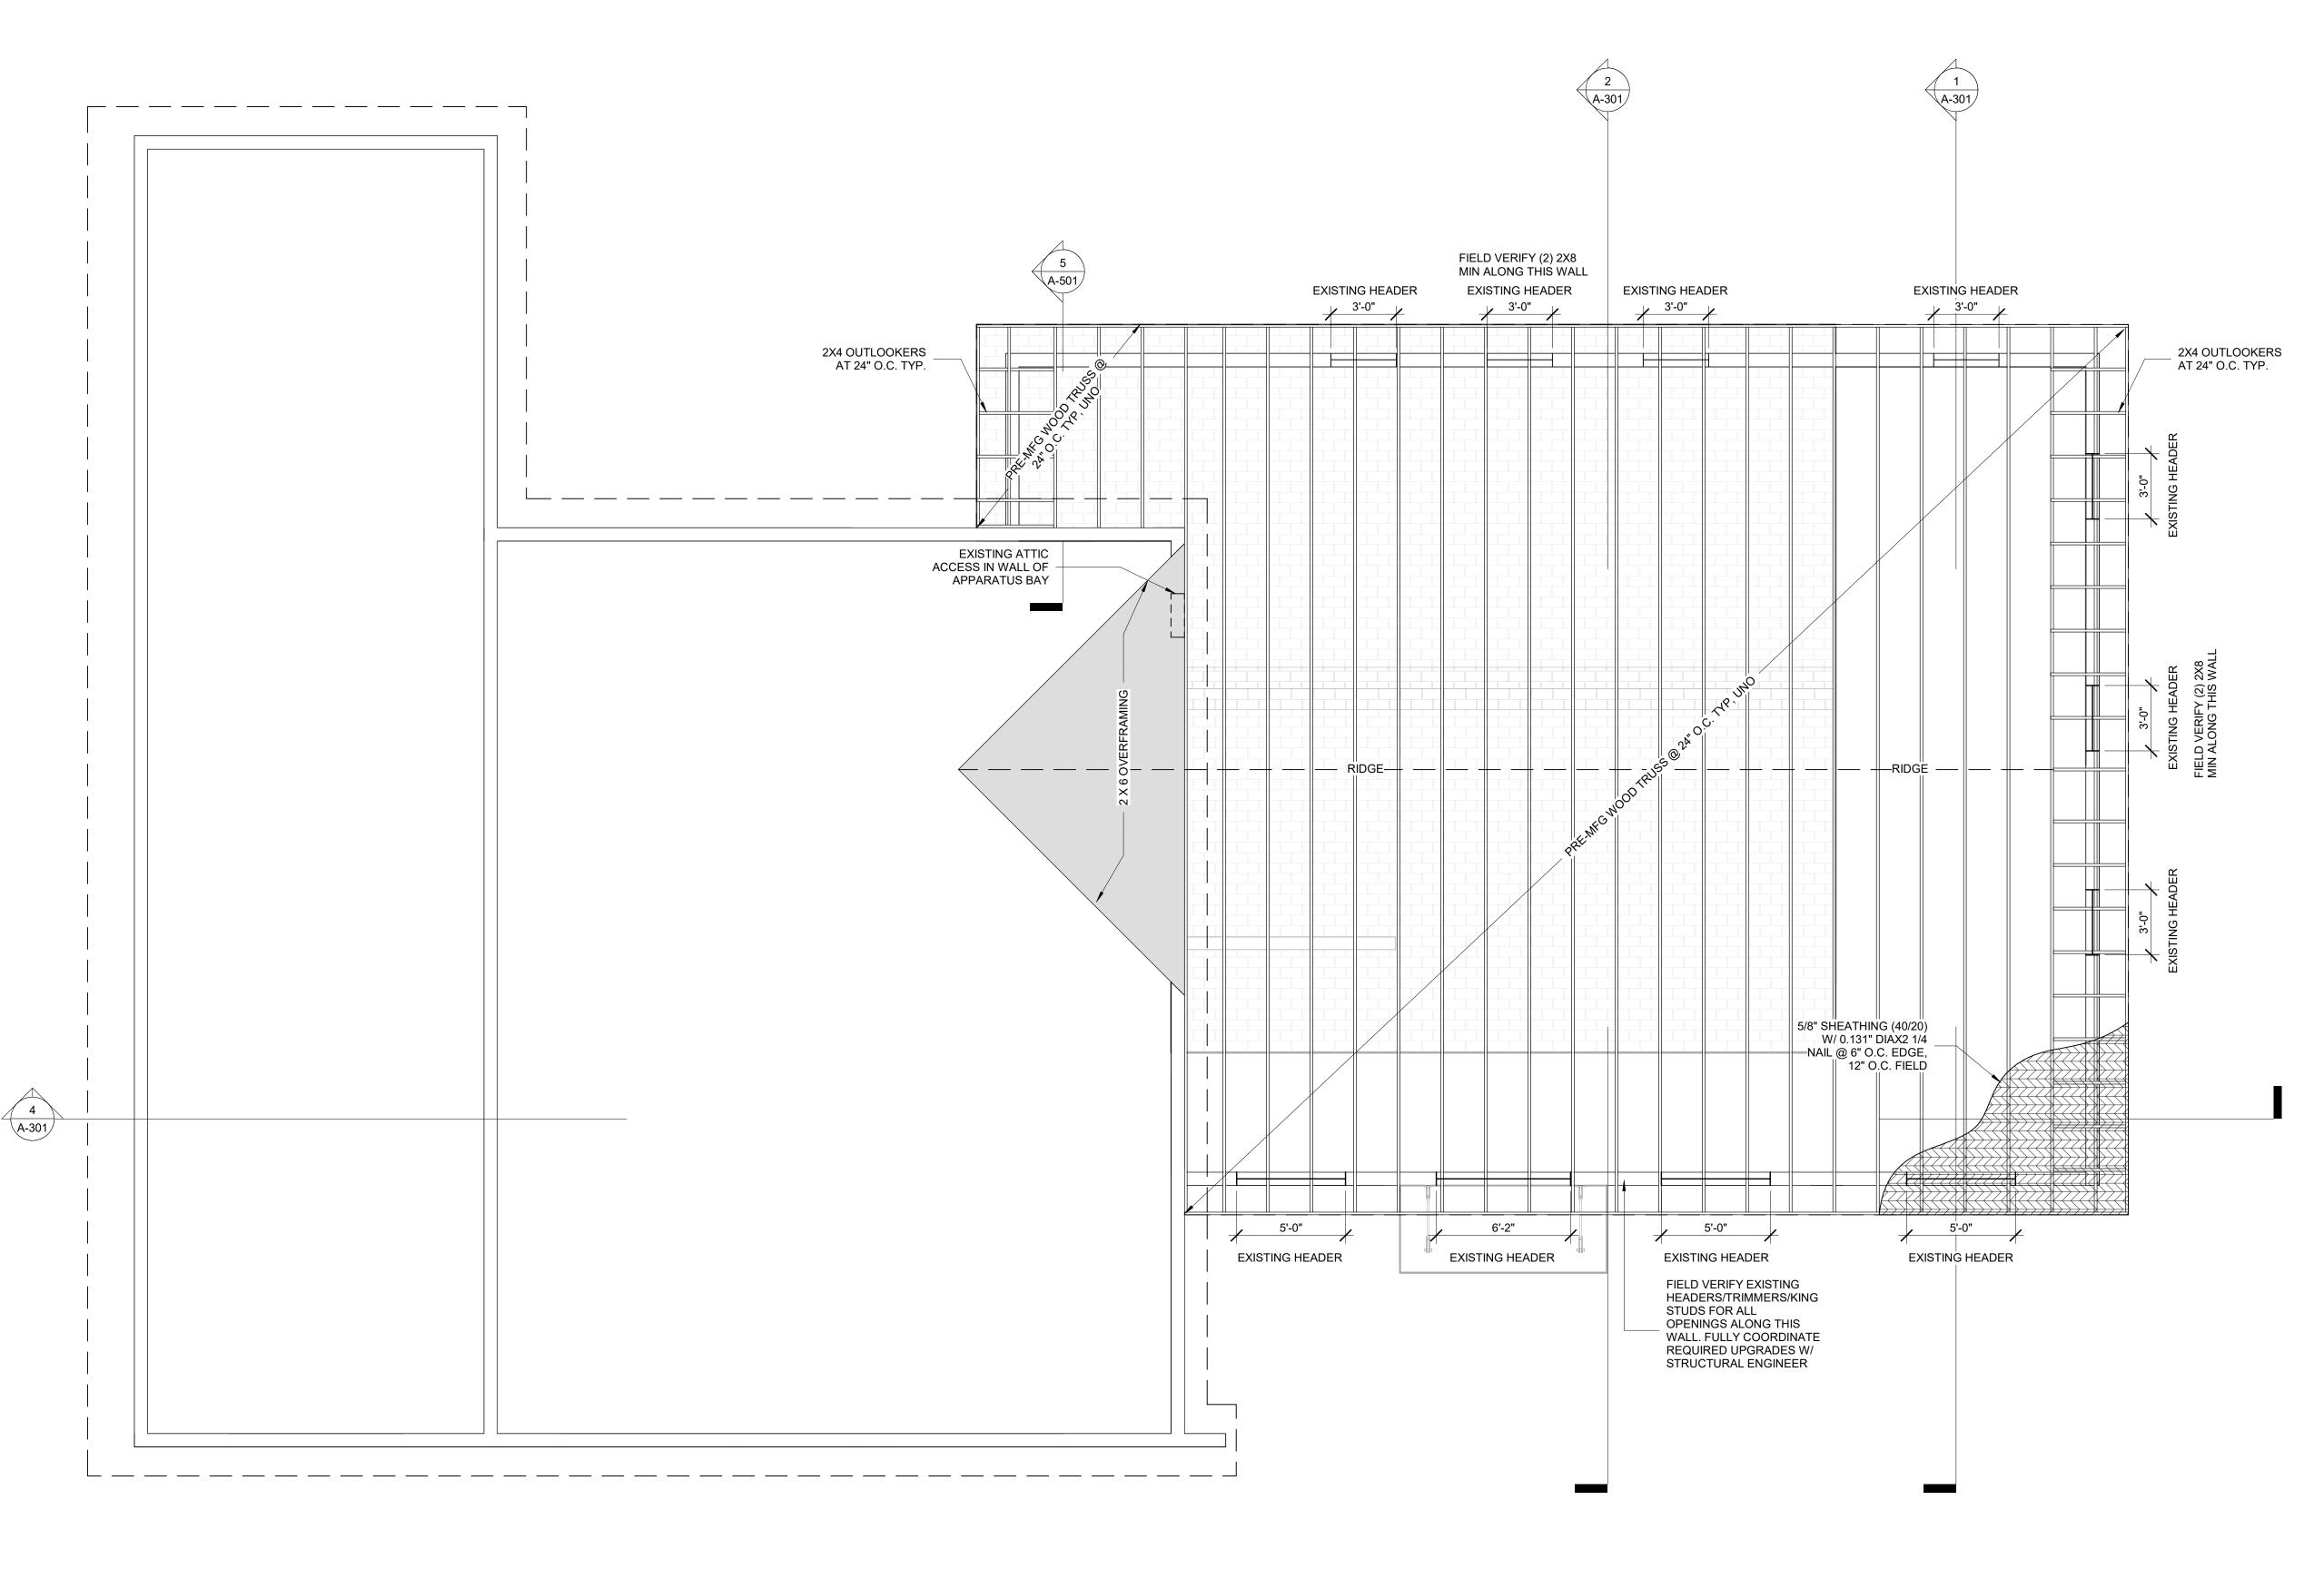

1 ROOF PLAN
1/4" = 1'-0"

## **GENERAL NOTES**

COORDINATE LOCATION OF MECHANICAL EQUIPMENT AND ROOF PENETRATIONS WITH ROOF TRUSS LOCTIONS
 VERIFY ALL ROOF PENETRATIONS WITH MECHANICAL, ELECTRICAL AND PLUMBING U/VENT STACK

## **ROOF LEGEND**

EXISTING FLU/VENT STACK

**EXISTING VENT** 

EXISTING EXHAUST VENT

EXISTING VENT

**EXISTING ANTENNA** 

SNOW ICE AND WATER SHIELD

## **KEY NOTES**

DOWNSPOUT

**GUTTER** 003 RIDGE VENT, SINGLE OVER

REMOVE SCUPPER AND DOWNSPOUT, FILL PENETRATION IN EXISTING PARAPET WITH FRAMING,

SHEATHING, PATCH SIDING CONTINUE MECHANICAL EQUIPMENT THROUGH NEW

SNOW ICE AND WATER SHIELD


ROOF MRFD MULL MISSOULA


DESCR DATE

PROJECT # 23.008 03.20.2023

DATE

**ROOF PLAN** 

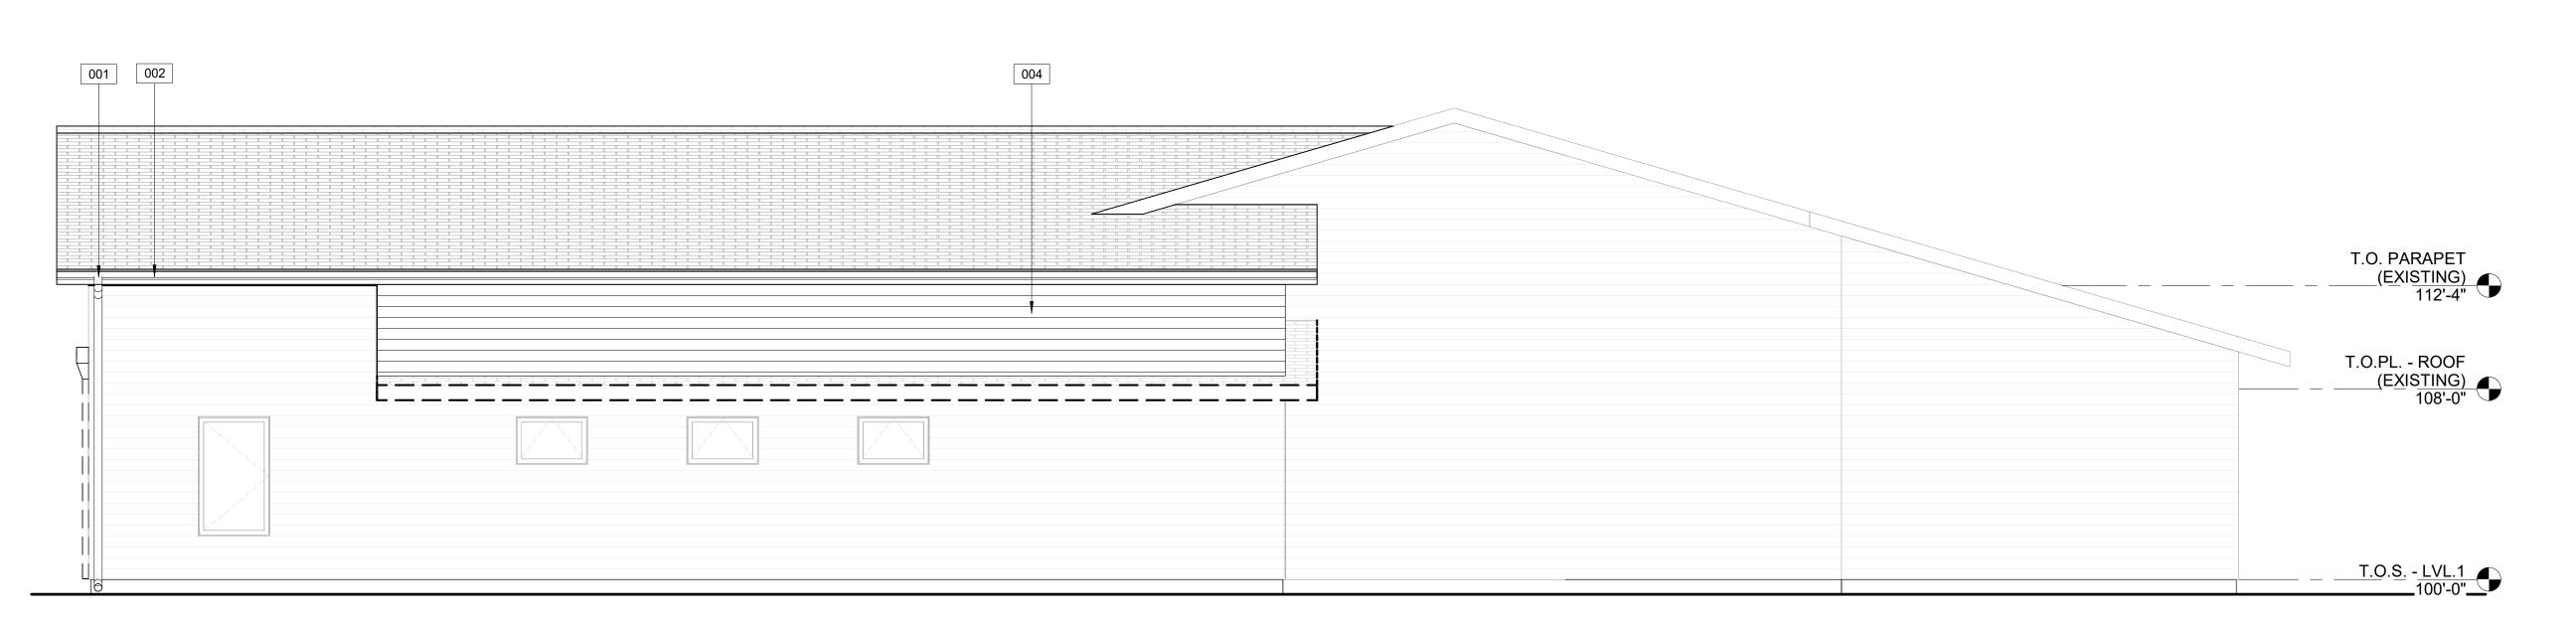

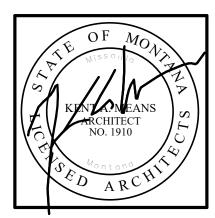

MMW
ARCHITECTS
406.543.5800
125 West Alder Street
Missoula, MT 59802


AN ROOF

MRFD MULL


LA RURAL MISSOUL

MISSOULA

1 NORTH
1/4" = 1'-0"

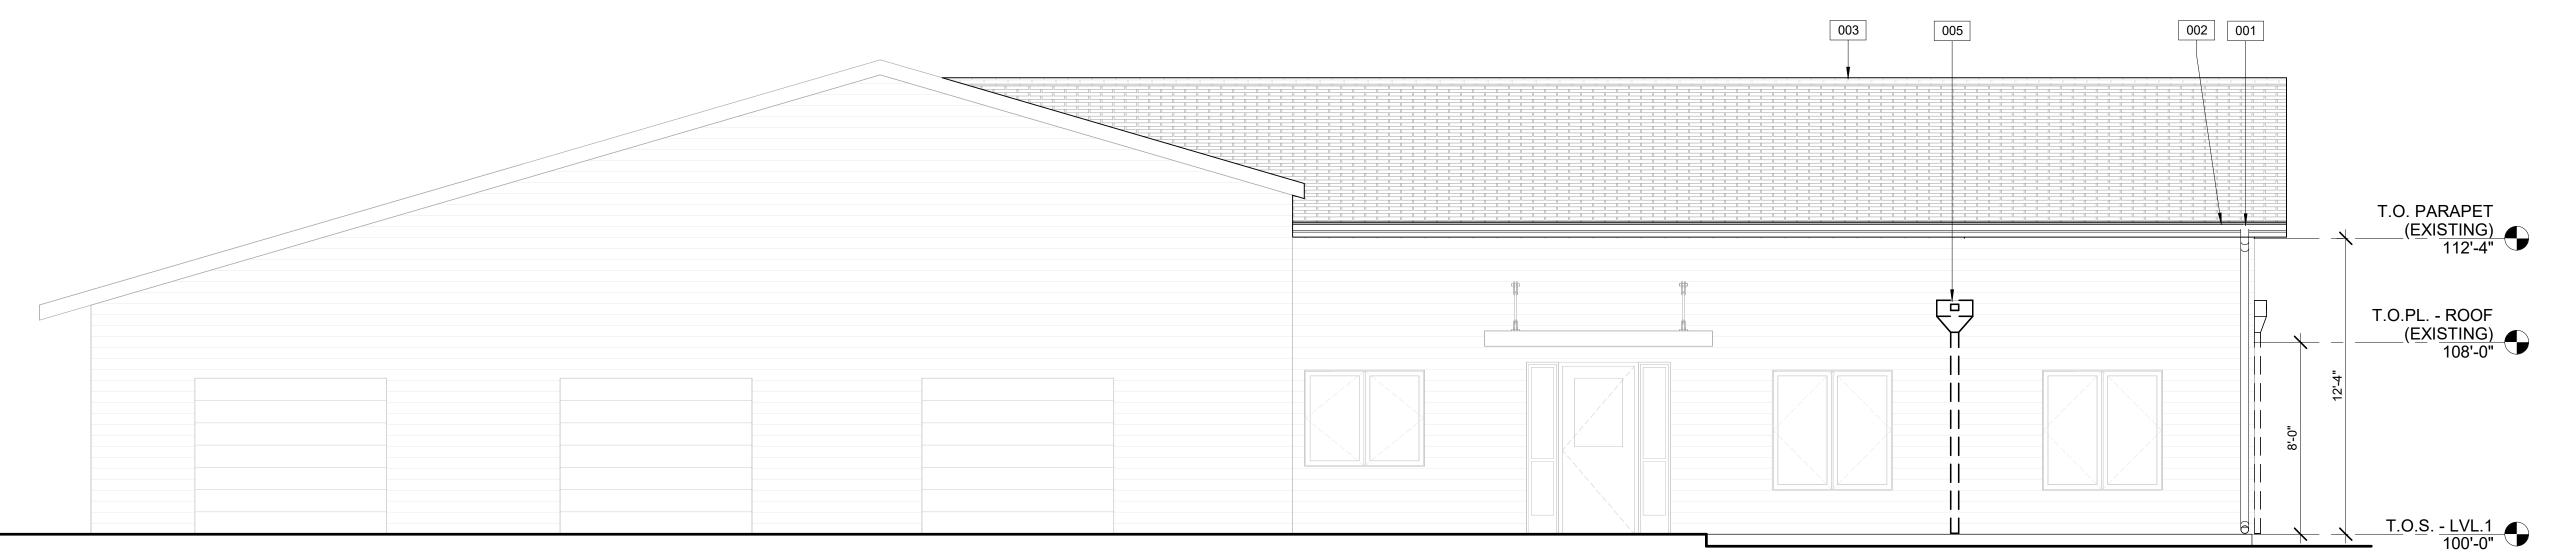

2 SOUTH
1/4" = 1'-0"

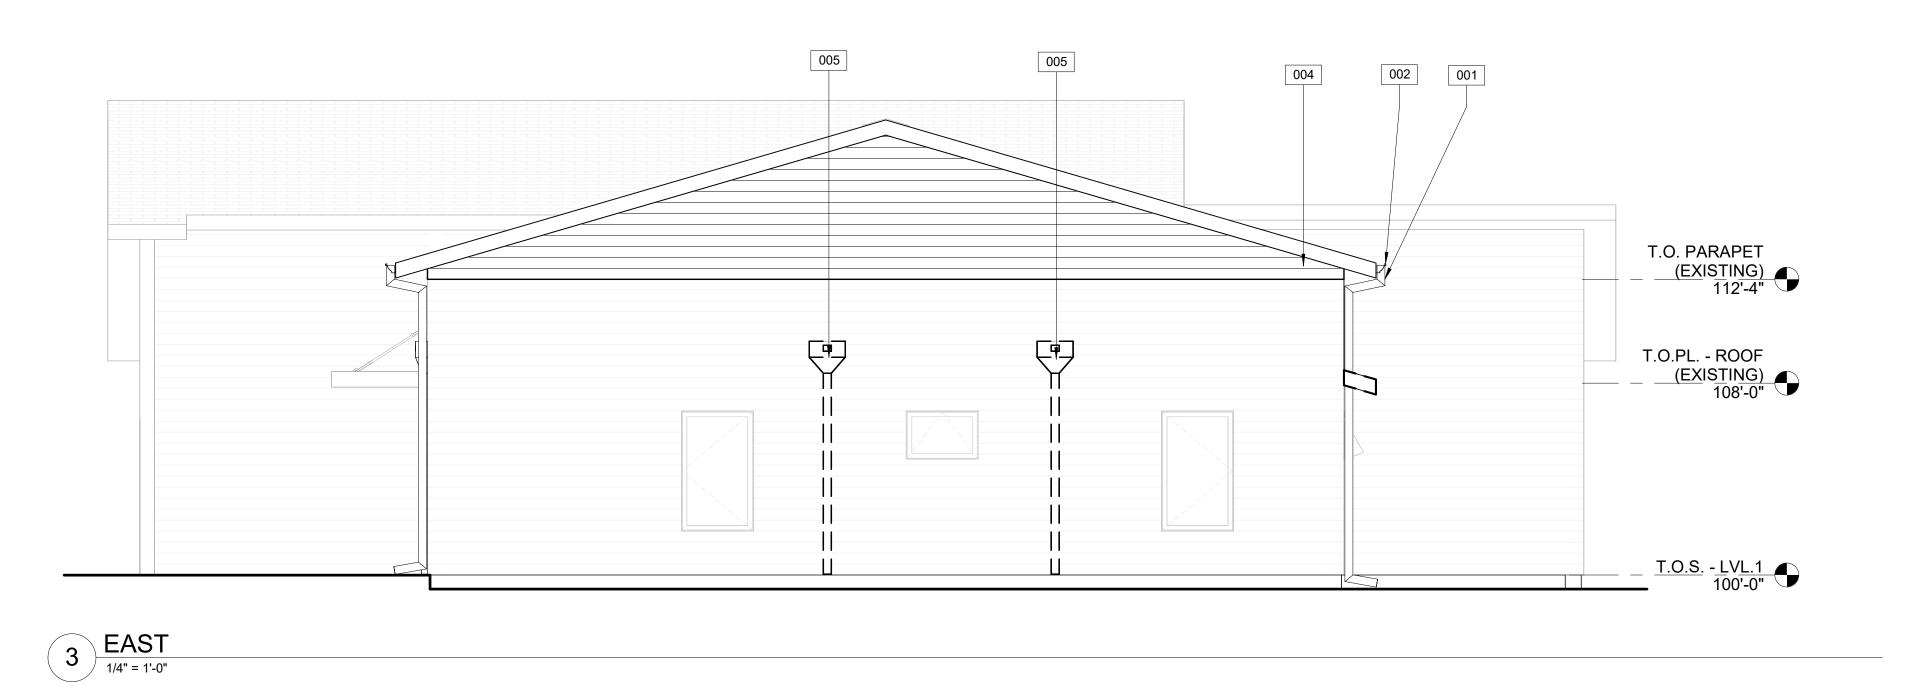

# LEGEND - ELEVATIONS EXISTING SIDING

	_			
<fy< td=""><td>NOTE</td><td>:S - F</td><td>  F\/A]</td><td>ΓΙΟΝ</td></fy<>	NOTE	:S - F	F\/A]	ΓΙΟΝ

001 DOWNSPOUT 002 GUTTER

002 GUTTER
 003 RIDGE VENT, SINGLE OVER
 004 NEW SIDING, MATCH EXISTIN

NEW SIDING, MATCH EXISTING REMOVE SCUPPER AND DOWNSPOUT, FILL PENETRATION IN EXISTING PARAPET WITH FRAMING, SHEATHING, PATCH SIDING


A-201

REVISION SCHEDULE

# DESCR DATE

PROJECT # 23.008

DATE 03.20.2023

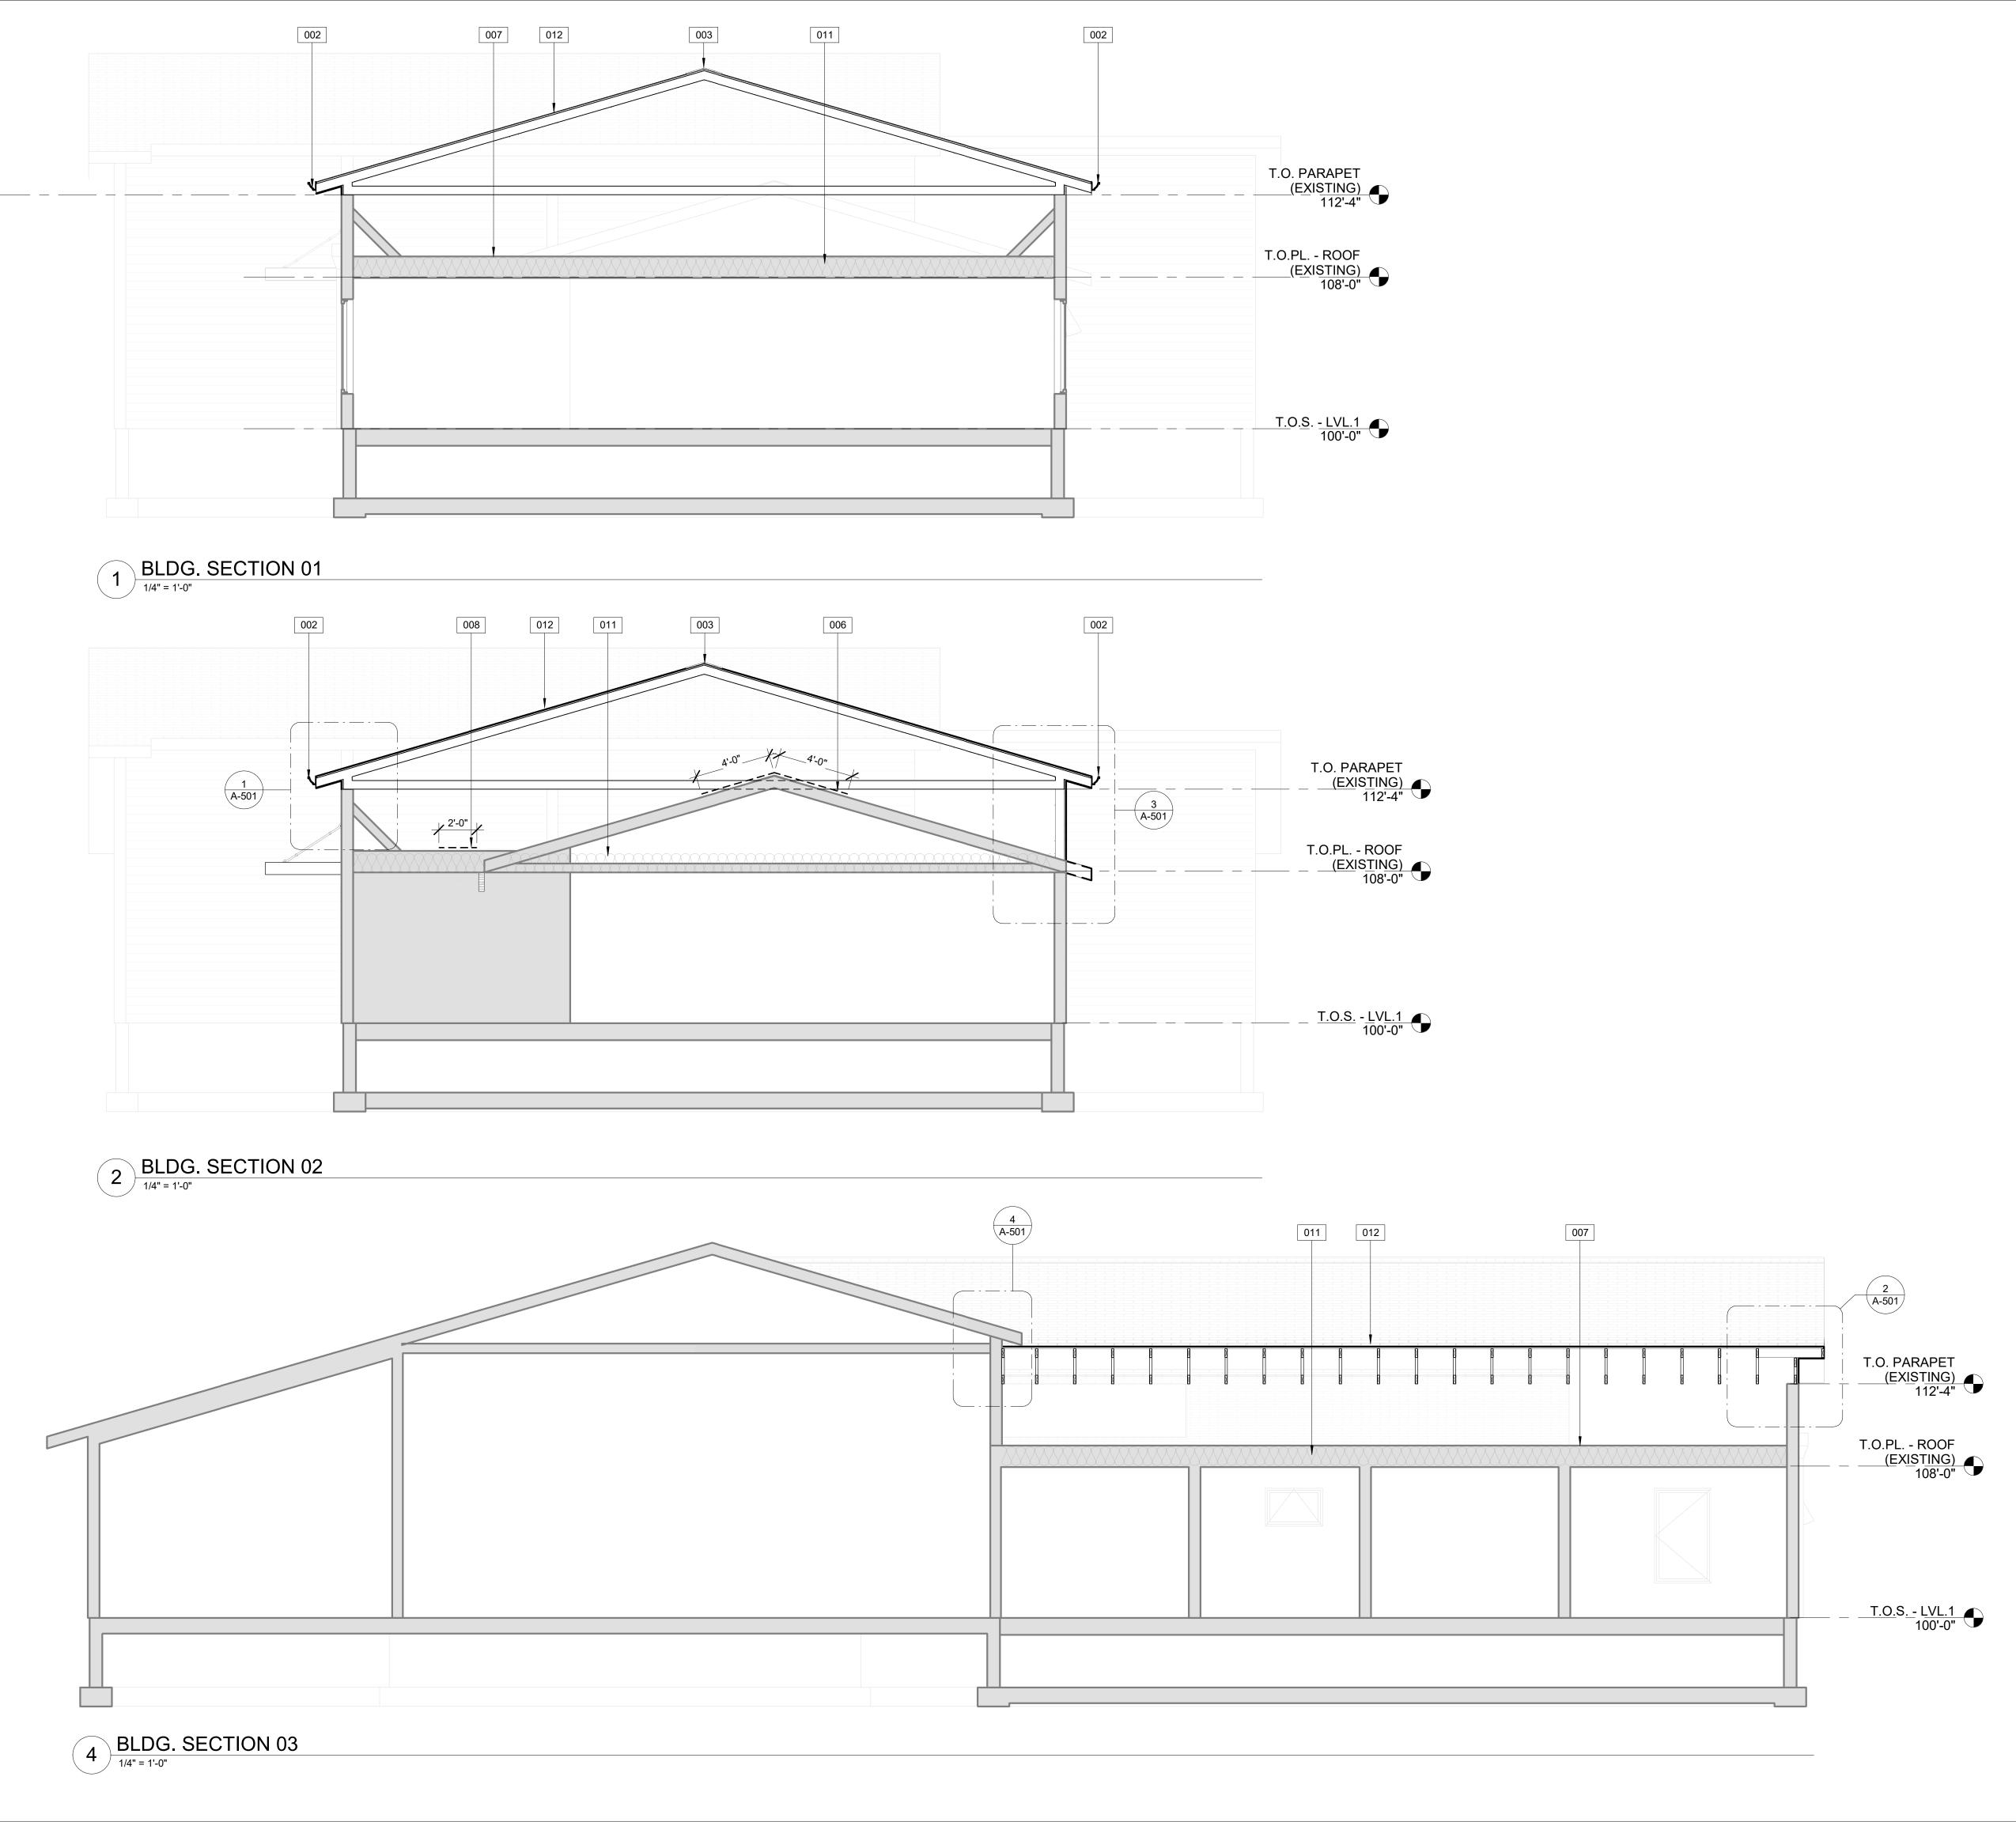

## **GENERAL NOTES**

SEE WINDOW AND DOOR LEGEND FOR WINDOW SIZES AND INFORMATION.
 SEE FLOOR PLANS FOR INTERIOR WALL TYPES.
 COORDINATE WITH MECHANICAL FOR CEILING FRAMING DEPTH. SEE ASSEMBLIES FOR CONTRACTOR'S OPTION FOR CEILING FRAMING TYPES.

## **KEY NOTES - SECTIONS**

**GUTTER** 002

003 RIDGE VENT, SINGLE OVER

REMOVE 4'-0" OF ROOFING AND SHEATHING FULL 006


LENGTH OF EXISTING ROOF

REMOVE ALL EXISTING ROOF MEMBRANE 007 800 REMOVE 2'-0" SECTION OF SHEATHING CONTIUOUS TO

ALLOW VENTILATION

EXISTING INSULATION TO REMAIN

ASPHALT SINGLES ON 30 LB FELT ON 5/8" SHEATHING ON PRE-MFG TRUSSES @ 24" O.C.

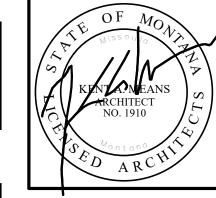

ARCHIT E 406.543.5800 125 West Alder Street Missoula, MT 59802  $\times$ 

ROOF MRFD MULL


DESCR DATE


PROJECT #

DATE 03.20.2023

> BUILDING SECTIONS

A-301

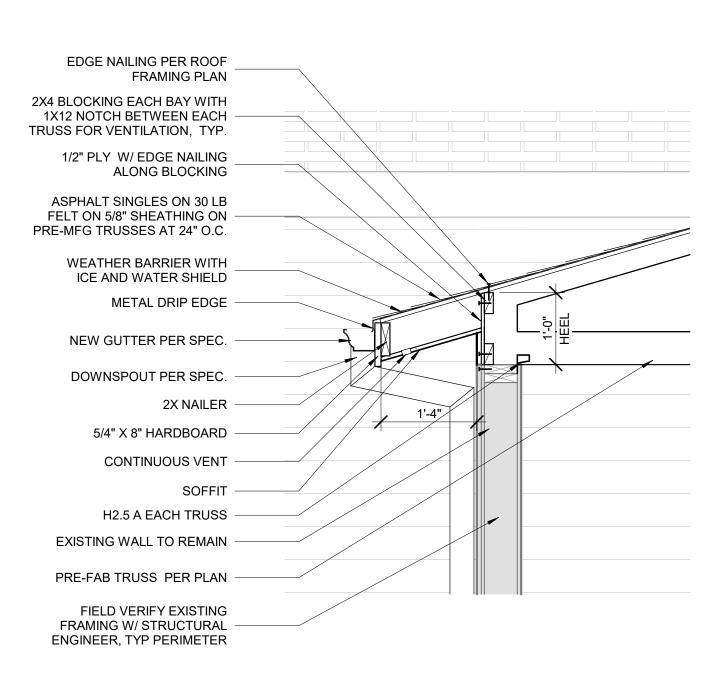

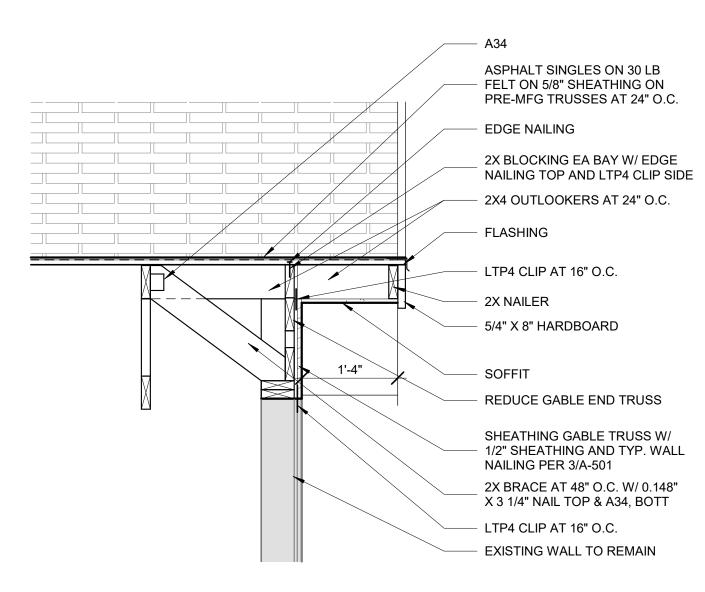

RAKE TYPICAL


EDGE NAIL


2X LEDGER W/ (2) 0.148" DIA X

3 1/4" NAIL AT EXÍSTING STUD

2X BLOCKING EA BAY



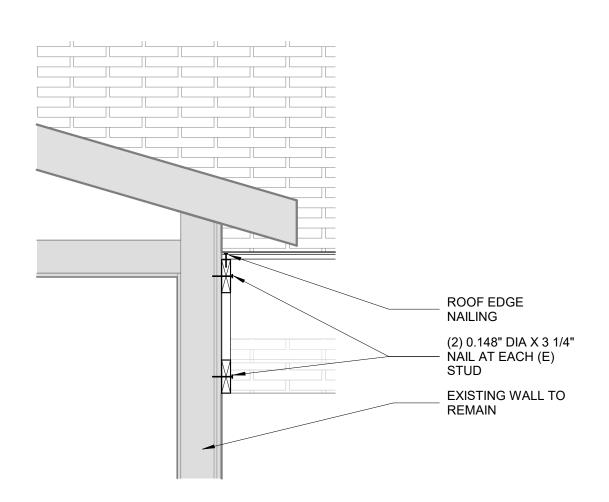


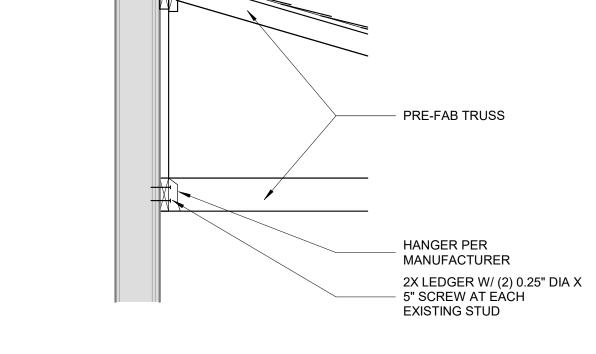


TRUSS WITH EXISTING WALL

3/4" = 1'-0"



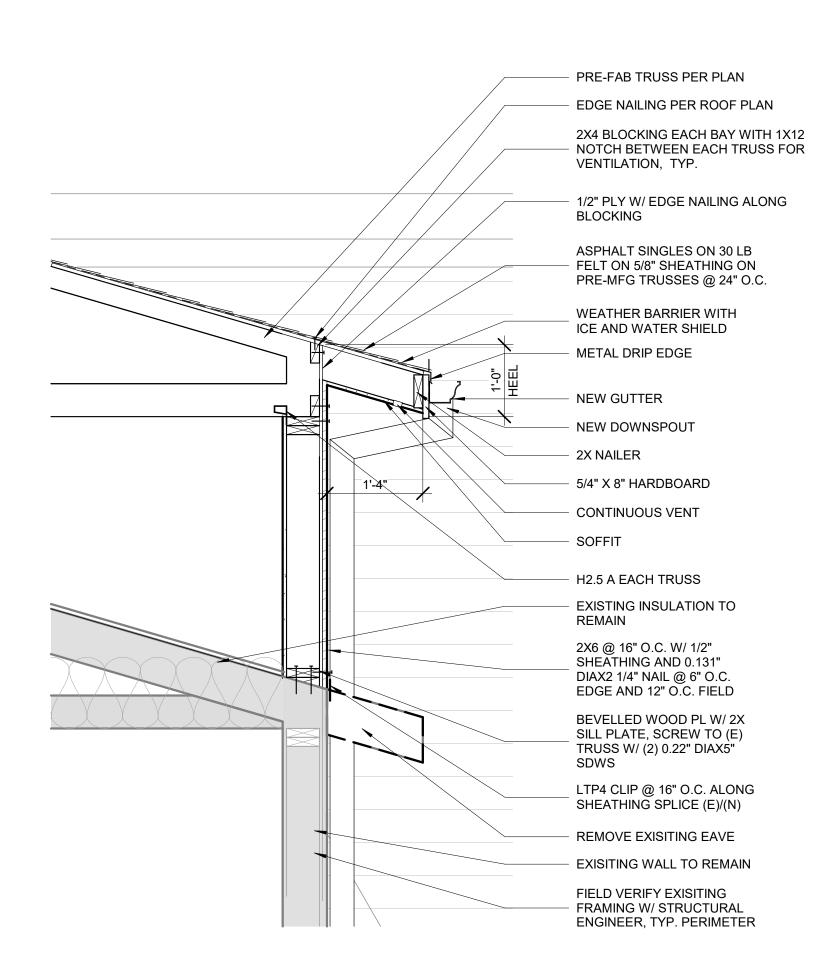

EAVE WITH NEW WALL

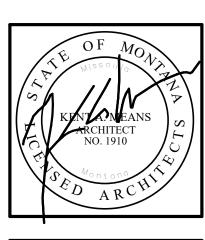

ARCHIT 406.543.5800 125 West Alder Stre Missoula, MT 59803

Q 0 MRFD MULL MISSOULA

DESCR DATE

PROJECT # 23.008

03.20.2023 DATE

> **EXTERIOR** DETAILS

A-501